

COORDINATE SYSTEM: CALIFORNIA STATE PLANE, ZONE II, NAD83, U.S. SURVEY FEET

### SOURCES:

- HYDROS ENGINEERING PLACER COUNTY GIS DATA





PO Box 81

(530) 637-4441 Weimar CA, 95736 hydros-engineering.com

### CHRISTIAN VALLEY PARK COMMUNITY SERVICES DISTRICT PLACER COUNTY, CALIFORNIA

CONTRACT DRAWINGS FOR

## KENNETH LOOP WATER PIPELINE PROJECT

**JULY 2024** 







## CHRISTIAN VALLEY PARK COMMUNITY SERVICES DISTRICT PLACER COUNTY, CALIFORNIA

CONTRACT DRAWINGS FOR

# KENNETH LOOP WATER PIPELINE PROJECT

JANUARY 2024

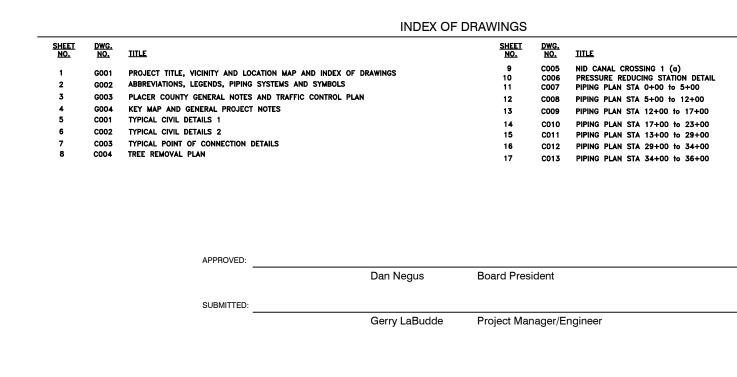

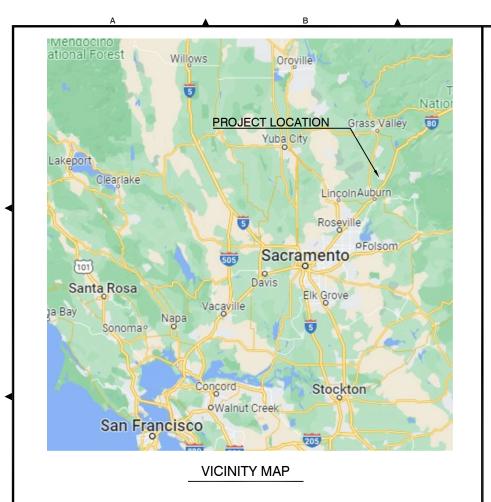



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CHECKED \_

JULY 2024

CVPC21-001

AS SHOWN

**Hydros**Engineering

CHRISTIAN VALLEY PARK COMMUNITY SERVICES DISTRICT PLACER COUNTY, CALIFORNIA


KENNETH LOOP WATER PIPELINE PROJECT

PROJECT TITLE, VICINITY AND LOCATION MAP AND INDEX OF DRAWINGS

DRAWING NUMBER SHEET NUMBER

NOT FOR CONSTRUCTION

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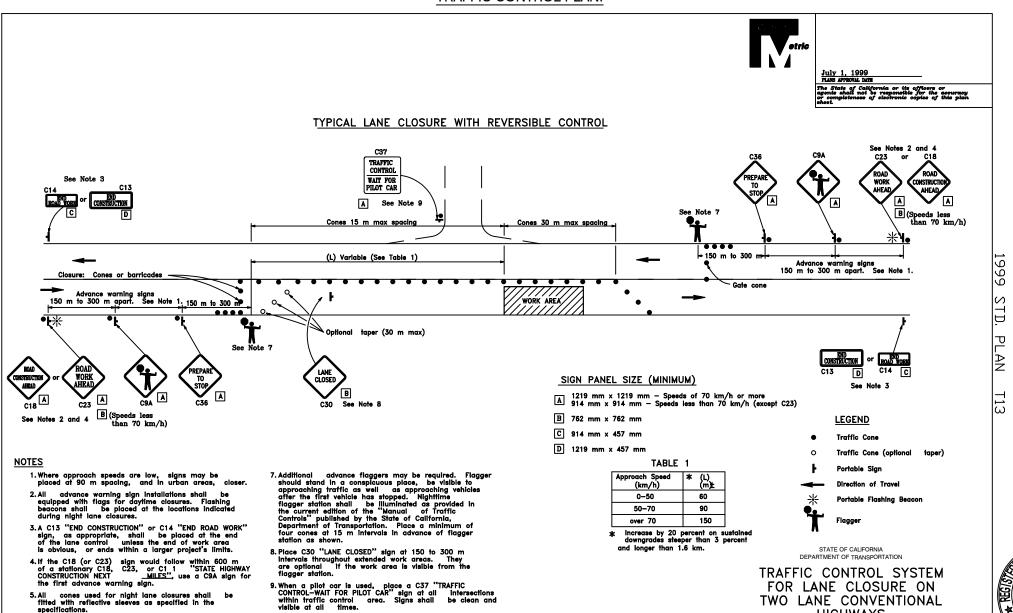
### PLACER COUNTY GENERAL NOTES:

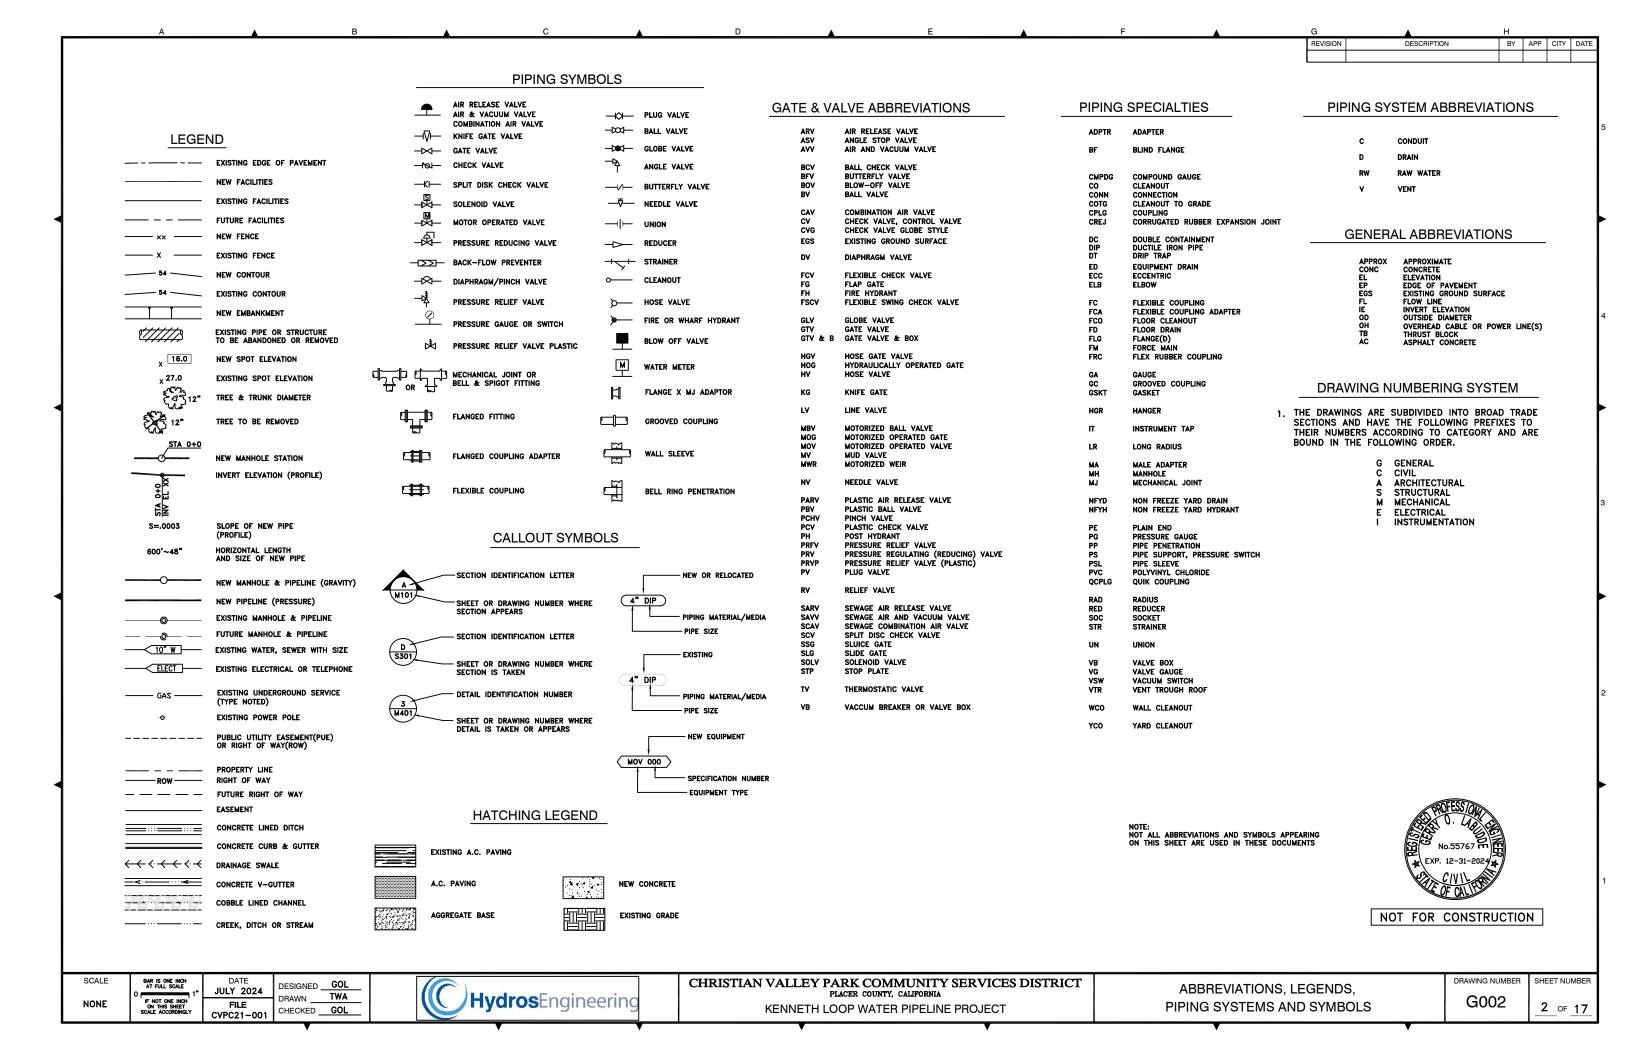- ALL CONSTRUCTION MATERIALS AND METHODS SHALL CONFORM TO THE REQUIREMENTS OF COUNTY OF PLACER GENERAL SPECIFICATIONS DATED OCTOBER, 1996. ALL REFERENCES TO STATE OF CALIFORNIA, DEPARTMENT OF TRANSPORTATION STANDARD SPECIFICATIONS SHALL REFER TO THE JULY, 2002 EDITION OF THE STANDARD SPECIFICATIONS. ATTENTION IS ALSO DIRECTED TO THE STANDARD DRAWINGS CONTAINED IN THE PLACER COUNTY LAND DEVELOPMENT MANUAL AND THE CURRENT EDITION OF THE CALTRANS STANDARD PLANS, WHICH, WHEN APPLICABLE, ARE INCLUDED IN THESE DRAWINGS AND REFERENCED BY PLATE OR STANDARD PLAN
- COUNTY, DEPARTMENT OR ENGINEER, AS USED ON THESE PLANS AND NOTES, REFERS TO THE DIRECTOR OF THE PLACER COUNTY DEPARTMENT OF PUBLIC WORKS OR AN AUTHORIZED AGENT APPOINTED BY THE DIRECTOR.
- PUBLIC SAFETY AND TRAFFIC CONTROL SHALL BE PROVIDED IN ACCORDANCE WITH COUNTY REQUIREMENTS AND AS DIRECTED BY THE ENGINEER. SAFE VEHICULAR AND PEDESTRIAN ACCESS SHALL BE PROVIDED AT ALL TIMES DURING CONSTRUCTION.
- ALL FIELD STAKING SHALL BE DONE BY A REGISTERED CIVIL ENGINEER OR LICENSED LAND SURVEYOR. THE OWNER SHALL PROVIDE ONE SET OF CONSTRUCTION CONTROL STAKES; ANY ADDITIONAL STAKING NECESSARY SHALL BE PROVIDED BY THE ENGINEER/SURVEYOR AT THE EXPENSE OF THE CONTRACTOR. ALL STAKING SHALL DONE PER SECTION 5-1.07 PLACER COUNTY GENERAL SPECIFICATIONS.
- THE CONTRACTOR IS HEREBY NOTIFIED THAT PRIOR TO COMMENCING CONSTRUCTION. HE IS RESPONSIBLE FOR CONTACTING ALL UTILITY COMPANIES FOR VENIFICATION AT THE CONSTRUCTION SITE OF THE LOCATIONS OF ALL UNDERGROUND FACILITIES WHERE SUCH FACILITIES MAY POSSIBLE CONFLICT WITH THE PLACEMENT OF THE IMPROVEMENTS SHOWN ON THESE PLANS, CALL "UNDERGROUND SERVICE ALERT" AT 800-642-2444 (2) DAYS MINIMUM TO FOURTEEN (14) DAYS MAXIMUM BEFORE ANY
- CONTRACTOR IS RESPONSIBLE FOR THE PROTECTION OF ALL EXISTING MONUMENTS AND OTHER SURVEY MARKERS. MONUMENTS AND SURVEY MARKERS DESTROYED DURING CONSTRUCTION SHALL BE REPLACED AT THE CONTRACTORS EXPENSE.
- ALL A.C. SURFACES SHALL BE SAW CUT ONE FOOT MINIMUM INSIDE THE EDGE OF PAYEMENT TO A NEAT, STRAIGHT LINE AND REMOVED. THE EXPOSED EDGE SHALL BE SEALED WITH EMULSION PRIOR TO PAVING. THE EXPOSED BASE MATERIAL SHALL BE GRADED, RECOMPACTED AND RESEALED PRIOR TO PAVING.
- CONTRACTOR SHALL MAINTAIN ADEQUATE DUST CONTROL PER SECTION 10, CALTRANS STANDARD SPECIFICATIONS.
- NO CONSTRUCTION SHALL BE DONE BETWEEN OCTOBER 15 AND MAY 1, WITHOUT A COUNTY APPROVED SEDIMENT AND EROSION CONTROL PLAN TO PREVENT SOIL EROSION. ALL EROSION AND SEDIMENTATION CONTROL MEASURES SHALL BE IN ACCORDANCE WITH THE SPECIFICATIONS AND RECOMMENDATIONS CONTAINED IN THE "EROSION AND SEDIMENT CONTROL GUIDELINES FOR DEVELOPING AREAS OF THE SIERRAS",
- 10. INSTALLATION AND MAINTENANCE OF EROSION CONTROL MEASURES ARE THE RESPONSIBILITY OF THE CONTRACTOR. THE CONTRACTOR SHALL BE RESPONSIBLE FOR THE PREVENTION OF SIGNIFICANT EROSION AND SILTATION ENTERING THE STORM DRAIN SYSTEM, NATURAL DRAINAGE COURSES AND/OR INTRUDING UPON ADJACENT ROADWAYS AND PROPERTIES. WINTERIZATION AND EROSION CONTROL SHOWN ON THESE PLANS IS INTENDED AS A GUIDE. ADDITIONAL EROSION CONTROL MEASURES MAY BE REQUIRED AS DETERMINED IN THE FIELD AND APPROVED BY THE ENGINEER. THIS RESPONSIBILITY SHALL APPLY THROUGHOUT THE COURSE OF CONSTRUCTION AND UNTIL ALL DISTURBED AREAS HAVE BECOME STABILIZED AND SHALL NOT BE
- 11. AFTER STRIPPING THE DEBRIS, ANY EXISTING LOOSE FILL, UNSUITABLE SOIL. SILTY SAND DEPOSITS, OR DISTURBED NATURAL SOILS SHALL BE EXCAVATED AND PROPERLY DISPOSED OF TO THE SATISFACTION OF THE ENGINEER.
- THE CONTRACTOR SHALL REMOVE ALL ROAD MARKINGS, PAVEMENT MARKERS, AND OTHER DELINEATION THAT ARE IN CONFLICT WITH THE DELINEATION SHOWN ON THE PLANS OR AS DIRECTED BY THE ENGINEER. THE CONTRACTOR SHALL LAYOUT ALL PAVEMENT MARKINGS FOR APPROVAL BY THE ENGINEER. AFTER APPROVAL, THE CONTRACTOR SHALL APPLY ALL PAINTED MARKINGS AND THERMOPLASTIC PAVEMENT MARKINGS NECESSARY TO COMPLETE THE WORK.
- 14. NOT USED.
- 16. CONTRACTOR MUST IMMEDIATELY REINSTALL ANY TRAFFIC SIGNS REMOVED IN THE COURSE OF CONSTRUCTION. ANY SIGNS LOST OR DAMAGED BY THE CONTRACTOR SHALL BE REPLACED OR REPAIRED BY THE CONTRACTOR AS DIRECTED BY THE
- TEMPORARY TRAFFIC STRIPING MUST BE PROVIDED BY THE CONTRACTOR IF DELINEATION IS DESTROYED DURING TRENCHING OR OTHER WORK. PAINTED MARKINGS OR STRIPING TAPE MAY BE USED. THE TEMPORARY STRIPING MUST BE APPROVED FOR MATERIAL AND LAYOUT BY THE ENGINEER BEFORE TRENCHING OR OTHER WORK IS STARTED. ALL TEMPORARY PAINTED MARKINGS THAT ARE TO BE REMOVED. SHALL BE SANDBLASTED BY THE CONTRACTOR AT THE EXPENSE OF THE CONTRACTOR.
- 18. THE COUNTY MAY REQUIRE THE CONTRACTOR TO UNCOVER ANY IMPROVEMENTS THAT HAVE BEEN COMPLETED WITHOUT PROPER COUNTY INSPECTION AND/OR APPROVAL. IF THE INSTALLATION IS FOUND NOT TO MEET COUNTY STANDARDS OR PREVIOUSLY APPROVED ALTERNATIVES SHOWN ON THE PLANS, THE CONTRACTOR MAY BE REQUIRED TO REMOVE AND REPLACE SUCH IMPROVEMENTS AT HIS EXPENSE.

- PRIOR TO ANY ACTIVITY OCCURRING WITHIN THE RIGHT-OF-WAY, THE CONTRACTOR SHALL INSTALL W20-1 (C23) SIGNS IN ACCORDANCE WITH PART 6 OF THE MANUAL ON UNIFORM TRAFFIC CONTROL DEVICES (MUTCD) 2003 AND THE MUTCD 2003
  CALIFORNIA SUPPLEMENT. THE SIGNS SHALL BE PROFESSIONALLY MADE, METAL,
  REFLECTORIZED AND PLACED ON WOODEN POSTS FOR THE DURATION OF THE PROJECT. THE MINIMUM SIZE SHALL BE 36". THE SIGNS SHALL BE REPLACED OR REPAIRED IF STOLEN OR DAMAGED. THE PLACEMENT, TYPE AND LOCATION OF THE TRAFFIC CONTROL DEVICES SHALL BE REVIEWED AND APPROVED BY THE COUNTY INSPECTOR. THE INSPECTOR SHALL DIRECT THE INSTALLATION OR CHANGES TO SIGNS, STRIPING, CONES BARRICADES ETC. DURING THE COURSE OF CONSTRUCTION FOR TRAFFIC SAFETY.
- 20. ONLY THE APPROXIMATE LOCATION OF THE EXISTING PIPING HAVE BEEN SHOWN. THE CONTRACTOR SHALL VERIFY EXACT LOCATION IN THE FIELD AND IMMEDIATELY NOTIFY THE PROJECT ENGINEER IF SAID LOCATION IS SIGNIFICANTLY DIFFERENT FROM THAT SHOWN ON THIS PLAN.
- 21. ENGINEER SHALL CERTIFY THAT THE VARIOUS ITEMS OF COMPACTION AND MATERIALS HAVE BEEN ACCOMPLISHED.

- 22. NOT USED.
- 23. TEMPORARY BENCHMARKS SHALL BE PROVIDED AS DEEMED NECESSARY PER FIELD COORDINATION BETWEEN THE ENGINEER/SURVEYOR AND THE CONTRACTOR. IN NO INSTANCE SHALL THE TEMPORARY BENCHMARKS BE SPACED MORE THAN 1000 FEET
- 24. STAGING OF CONSTRUCTION EQUIPMENT AND MATERIALS WILL NOT BE PERMITTED WITHIN PLACER COUNTY RIGHT OF WAY.
- 25. TRAFFIC CONTROL SHALL BE PER CALTRANS STANDARD PLAN T13 (SEE THIS SHEET) AND SHALL PROVIDE AND MAINTAIN A MINIMUM OF ONE 10-FOOT SURFACED LANE, WITH TRAFFIC CONTROL, DURING WORKING HOURS. DURING NON-WORKING HOURS WITH TRAFFIC CONTROL, DURING WOOKING HOURS. DURING NON-WORKING HOURS (SHUT-DOWNS, NIGHTS & WEEKENDS) TWO 10-FOOT SURFACED LANES SHALL BE PROVIDED. CONTRACTOR SHALL PLACE AND SECURE STEEL PLATES OVER TRENCH DURING NON-WORKING HOURS. NO MORE THAN 300 FEET OF LANE CLOSURE SHALL BE PERMITTED DURING WORKING HOURS. A TRAFFIC CONTROL PLAN MUST BE SUBMITTED AND APPROVED AT LEAST 48 HOURS PRIOR TO ANY WORK IN THE ROADWAY.

### TRAFFIC CONTROL PLAN:



DESIGNED \_\_\_GOL JULY 2024 DRAWN TWA AS SHOWN CHECKED FJF CVPC21-001

CHRISTIAN VALLEY PARK COMMUNITY SERVICES DISTRICT KENNETH LOOP WATER PIPELINE PROJECT

PLACER COUNTY **GENERAL NOTES AND** TRAFFIC CONTROL PLAN

TWO LANE CONVENTIONAL

**HIGHWAYS** NO SCALE

DRAWING NUMBER

T13

DESCRIPTION

BY APP CITY DATE

REVISION


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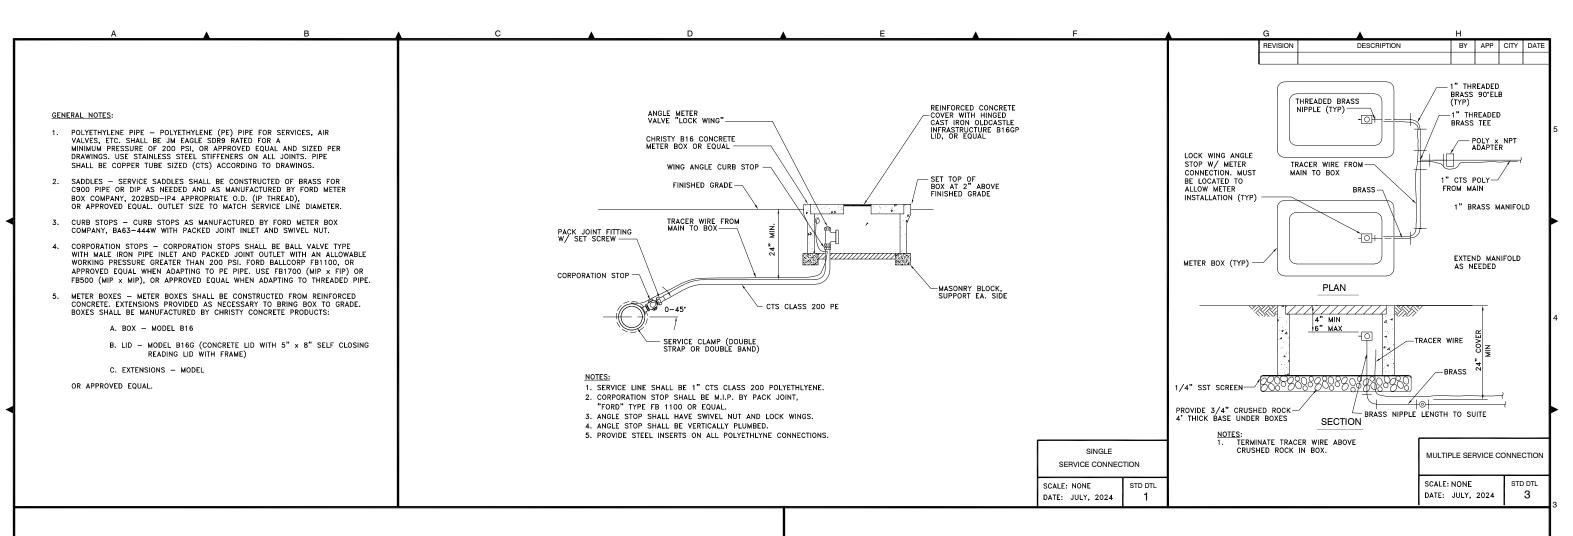
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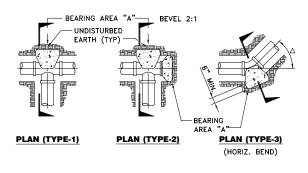
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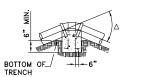
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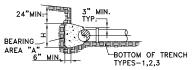
NOT FOR CONSTRUCTION









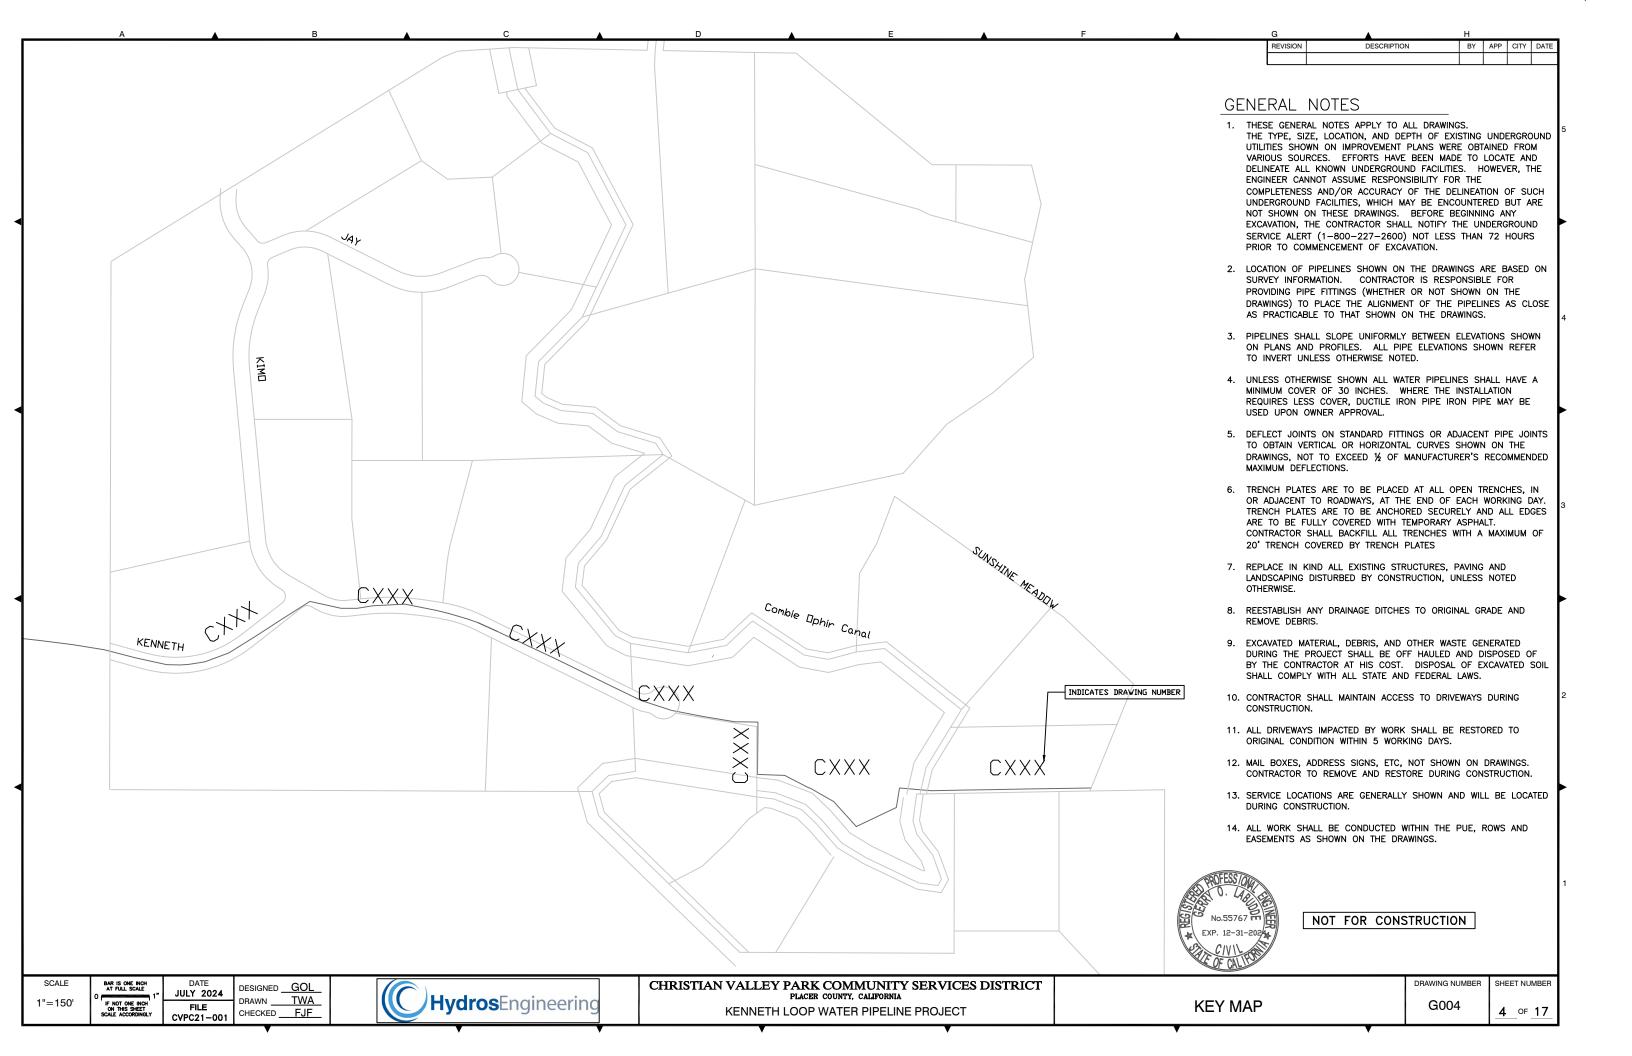

ELEV. (TYPE-4) (VERT. BEND)

SECTION

SCALE

NONE

THRUST BLOCKS ARE ONLY ALLOWED AT LOCATIONS SPECIFIED BY PIPE SERVICE OR AS APPROVED BY THE ENGINEER. PIPE TEST PRESSURE LESS THAN OR EQUAL TO 10 psi DO NOT REQUIRE RESTRAINT, TEST PRESSURE GREATER THAN 10 psi REQUIRE RESTRAINT. AREAS GIVEN ARE FOR 10 psi, ADJUST AREAS ACCORDING TO TEST PRESSURE. SEE SPECIFICATION SECTION 15010.


- 2. BLOCKS TO BE POURED AGAINST UNDISTURBED SOIL.
- 3. JOINTS AND FACE OF PLUGS SHALL BE KEPT CLEAN OF CONCRETE.

		THE	RUST	BLO	<u>DCKS</u>	SCI	HEDU	<u>LE</u>			
PIPE DIA. (in.)	TEST PESSURE (P.S.I.)	THRUST BLOCK BEARING AREA "A" (S.F.)  ANCHOR BLOCK VOL. OF CONCRETE (C.Y.)									
		90 <b>.</b> ▽		∆ 45*		△ 22.5*		∆ 11.25*		TEE OR BULKHEAD	
8"	10	0.5	0.16	0.3	0.10	0.1	0.03	0.1	0.03	0.3	0.10
10"	10	0.8	0.26	0.4	0.13	0.2	0.07	0.1	0.03	0.5	0.16
12"	10	1.1	0.36	0.6	0.19	0.3	0.10	0.2	0.07	0.8	0.26
14"	10	1.5	0.48	0.8	0.26	0.4	0.13	0.2	0.07	1.1	0.36
16"	10	2.0	0.65	1.1	0.37	0.5	0.17	0.3	0.10	1.4	0.47
18"	10	2.5	0.83	1.4	0.47	0.7	0.23	0.3	0.10	1.8	0.60
20"	10	3.1	1.00	1.7	0.57	0.9	0.29	0.4	0.13	2.2	0.73
24"	10	4.4	1.42	2.4	0.77	1.2	0.39	0.6	0.19	3.1	1.00
30"	10	6.9	2.23	3.8	1.23	1.9	0.61	1.0	0.33	4.9	1.58
36"	10	10.0	3.23	5.4	1.74	2.8	0.90	1.4	0.45	7.1	2.30
42"	10	13.6	4.39	7.4	2.39	3.8	1.23	1.9	0.61	9.6	3.10

REBAR SIZES				
PIPE SIZE	Δ	REBAR		
6"-10"	0-90*	#5		
12"-20"	0-225	#5		
24"	0-225	#6		
12"-20"	45°	#7		
12"-16"	90°	#8		

NOTE: COAT REBAR WITH TWO COATS OF KOPPERS 505, TNEMEC 46-450, OR EQUAL, 15 MILS EA. COAT

TYPICAL THRUST BOLCK SCALE: NONE DATE: JULY, 2024

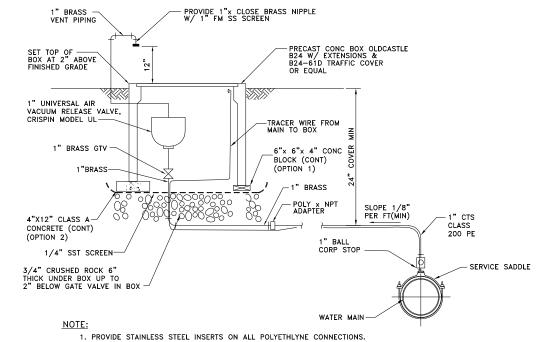

AIR RELEASE VALVE STD DTL


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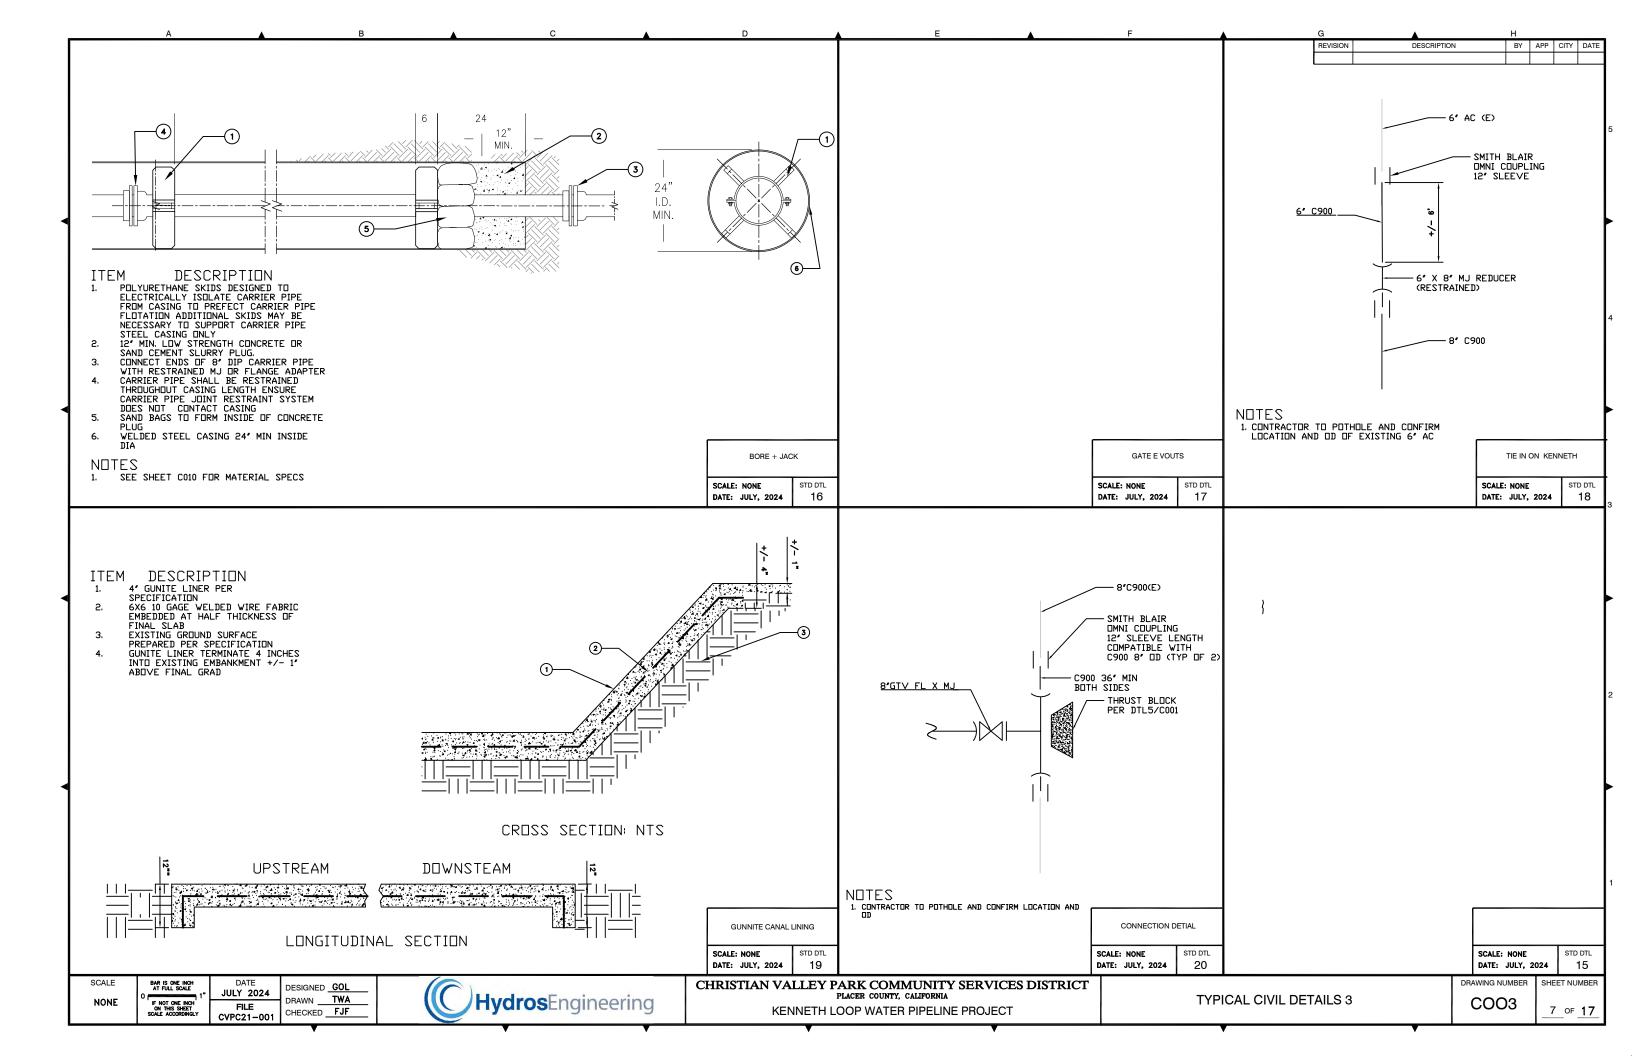
TYPICAL CIVIL DETAILS 1


DATE: JULY, 2024 DRAWING NUMBER SHEET NUMBER C001 5 of 17


IS ONE INCH FULL SCALE	DATE JULY 2024	DESIGNED GOL	(C) Hardwa o Farain a anima
IOT ONE INCH THIS SHEET	FILE		Hydrosengineering
ACCORDINGLY	CVPC21_001	CHECKED _ F JF	


CHRISTIAN VALLEY PARK COMMUNITY SERVICES DISTRICT KENNETH LOOP WATER PIPELINE PROJECT




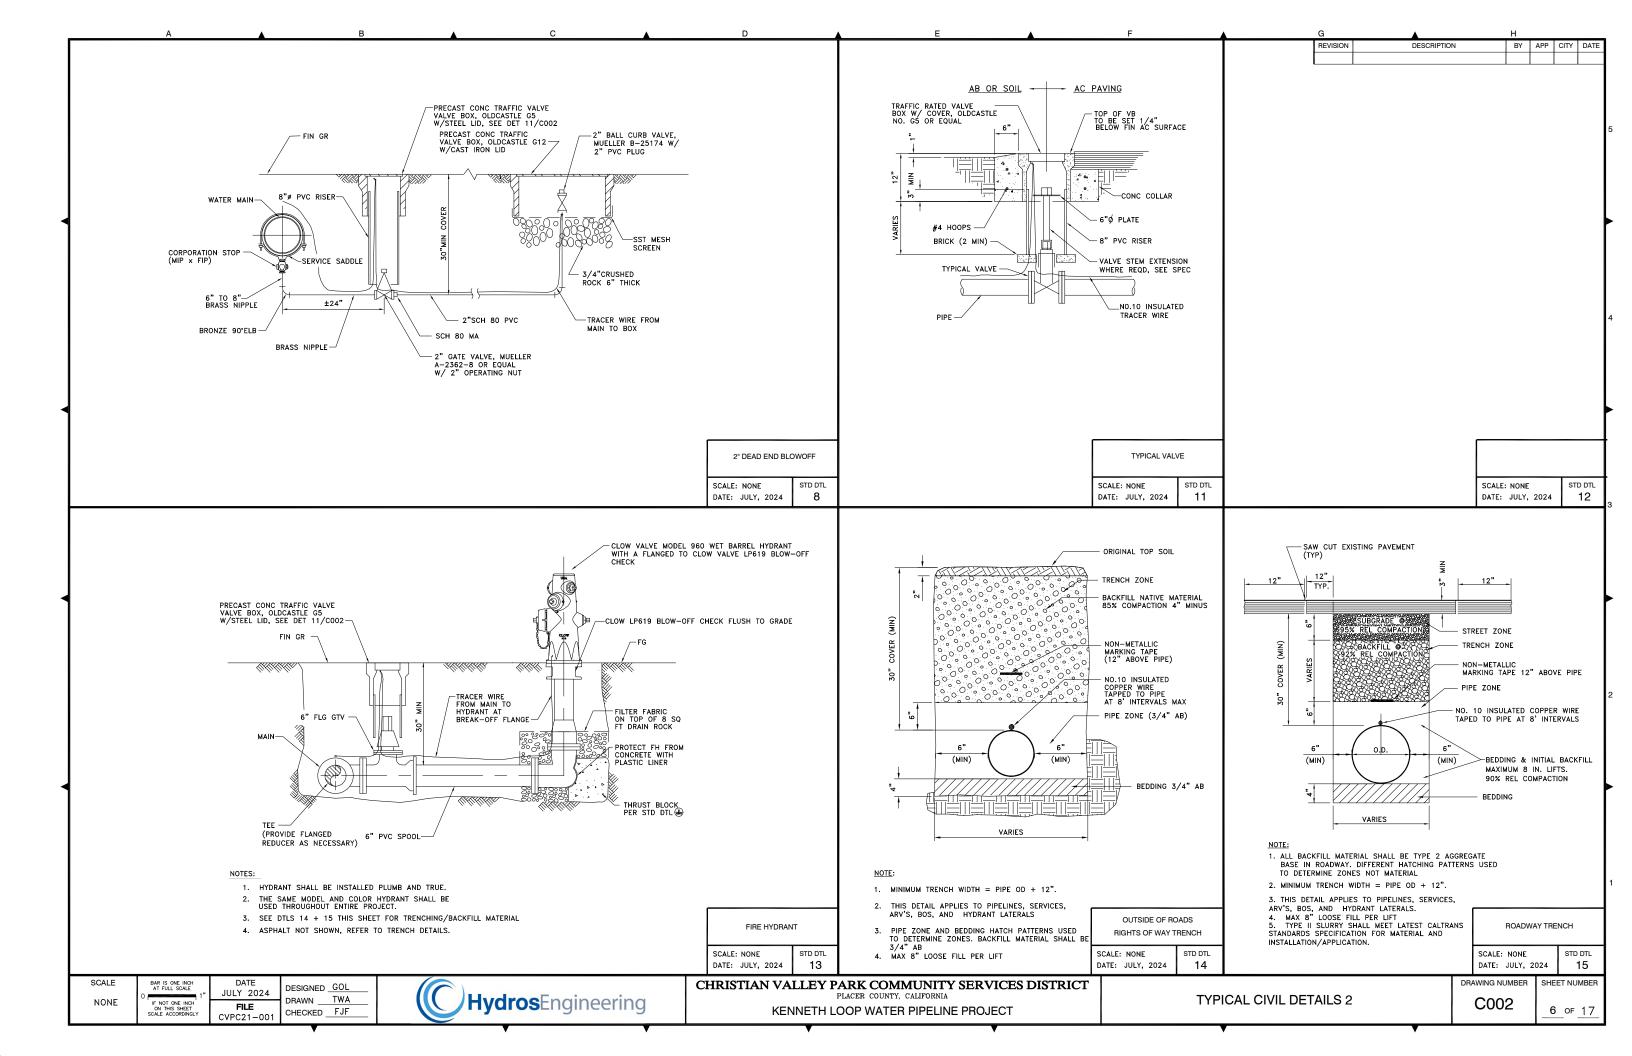

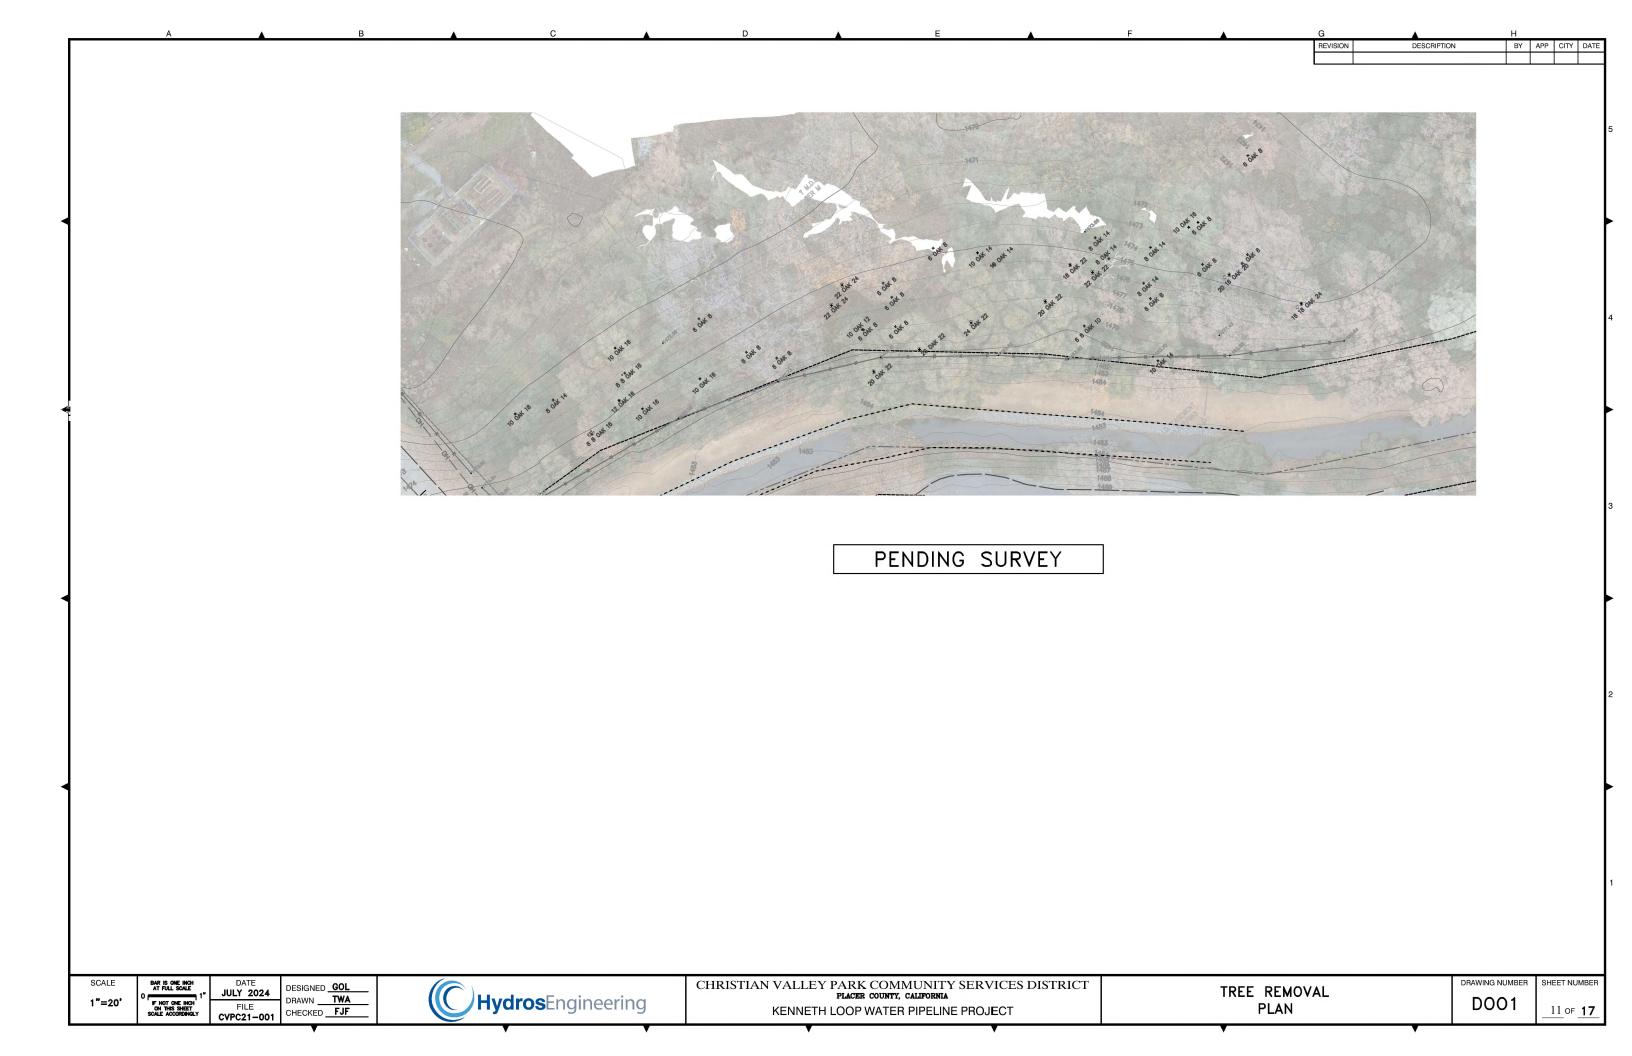

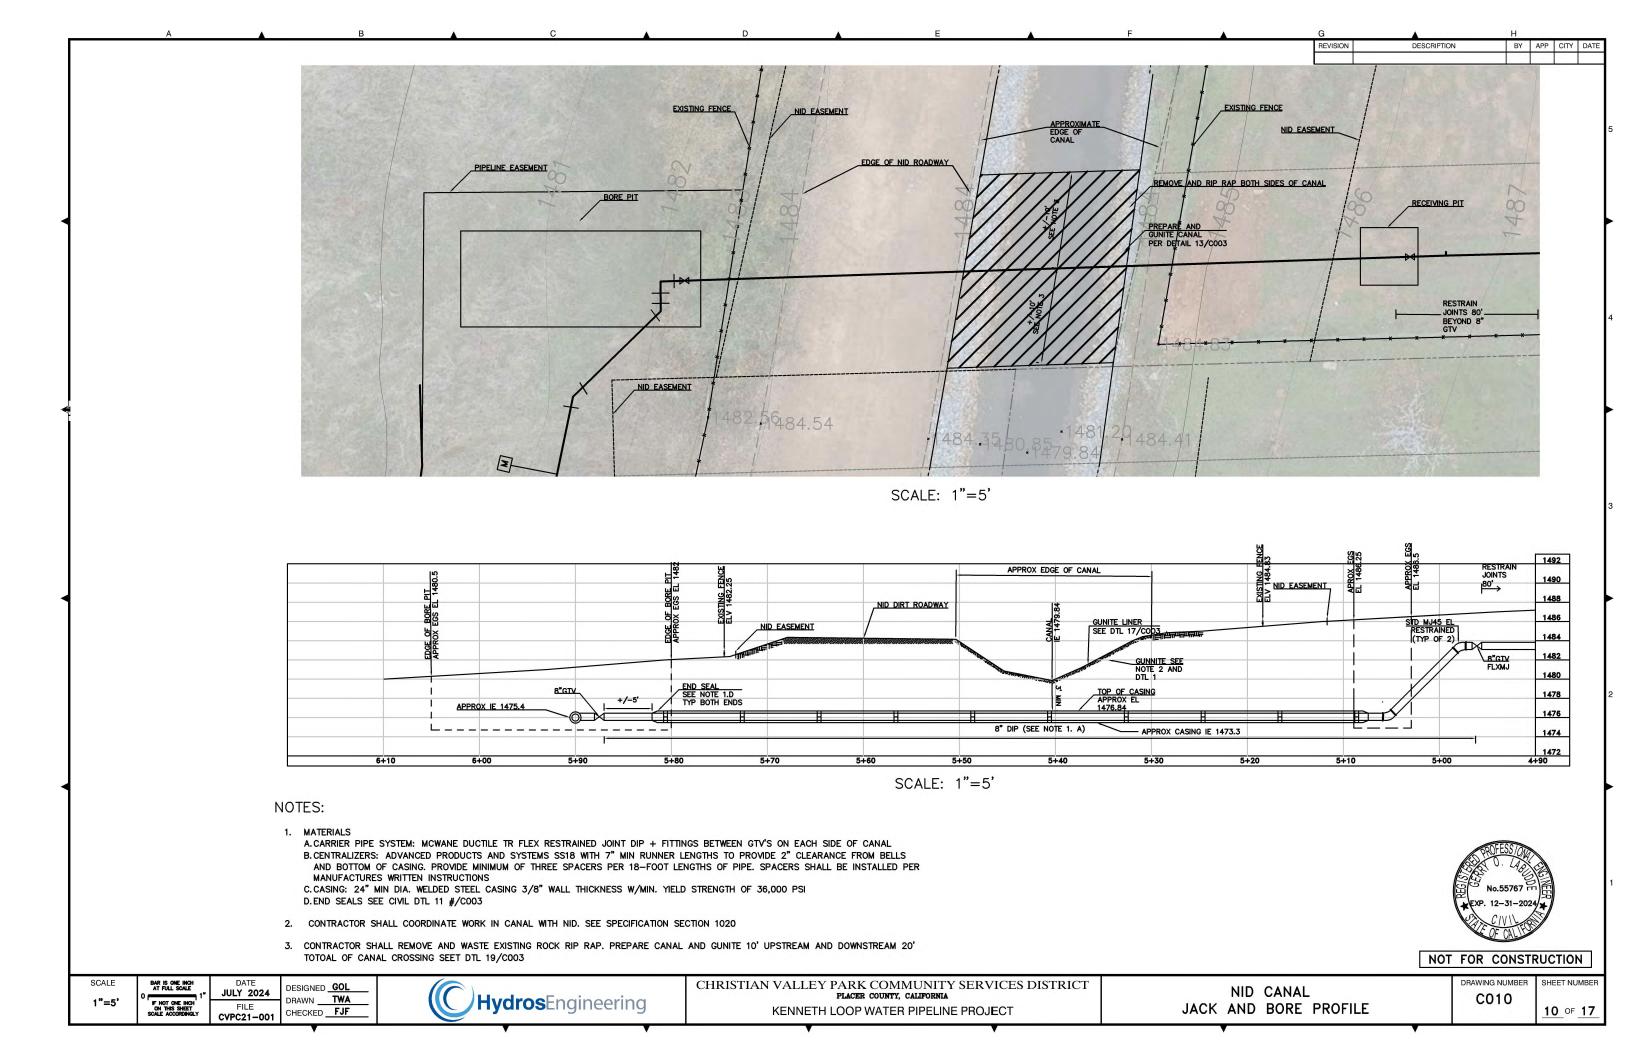

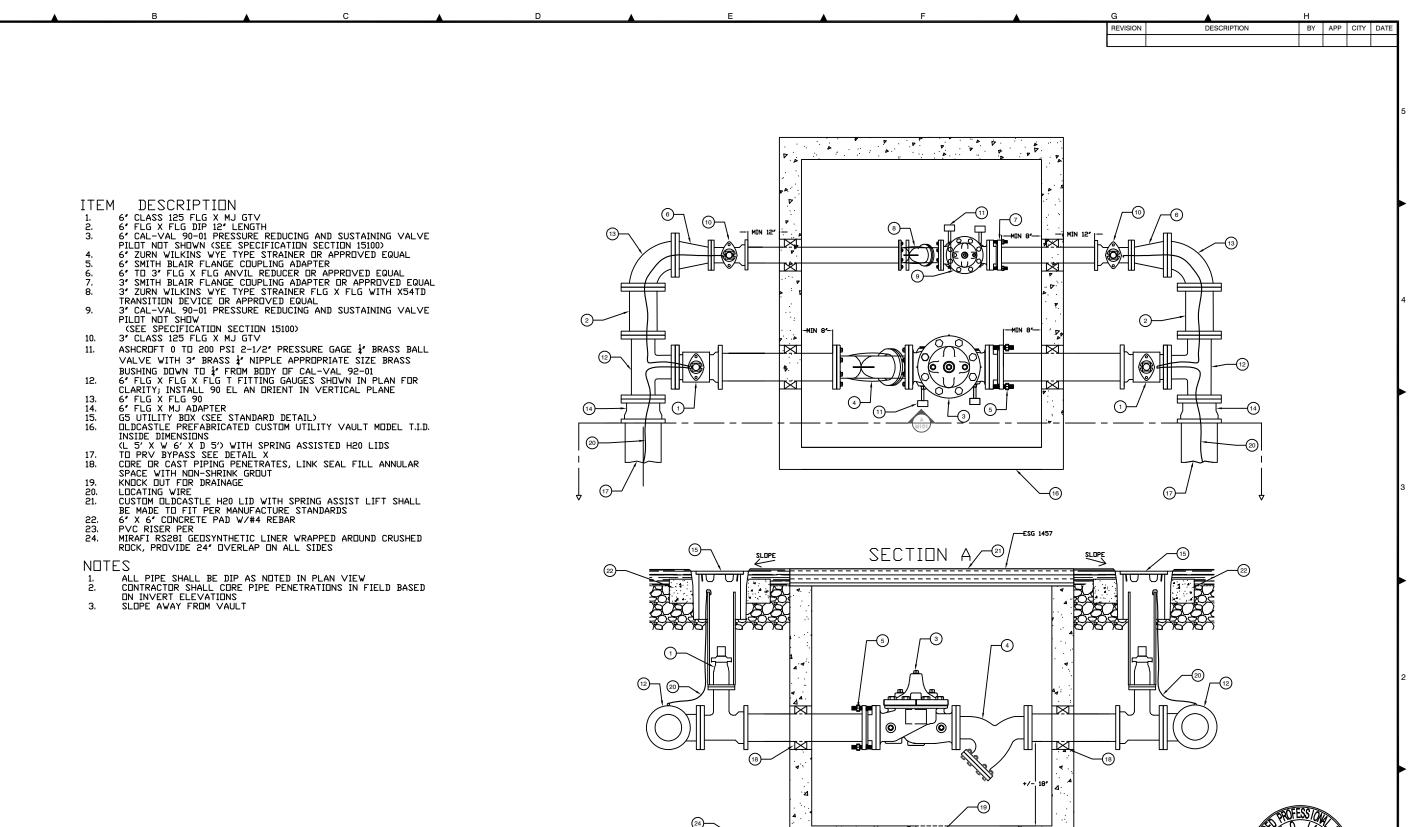

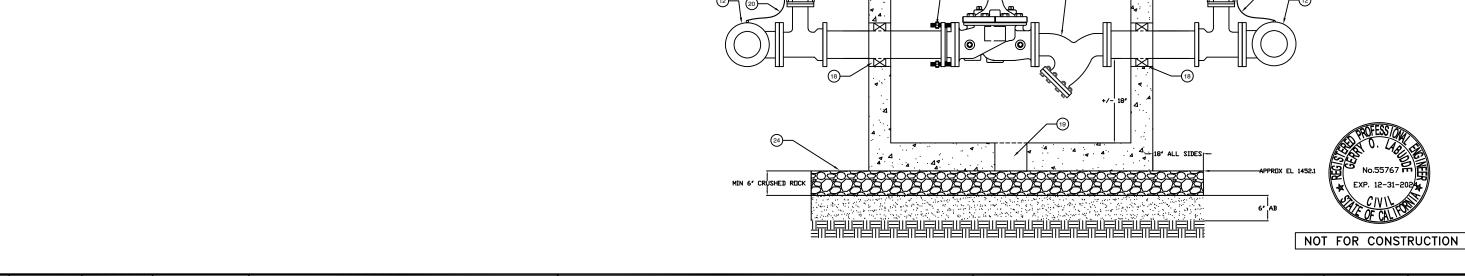

SCALE

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JULY 2024

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CVPC21-001




CHRISTIAN VALLEY PARK COMMUNITY SERVICES DISTRICT PLACER COUNTY, CALIFORNIA


KENNETH LOOP WATER PIPELINE PROJECT

PRESSURE RECUCING STATION DETAIL


DRAWING NUMBER SHEET NUMBER

9 of 17

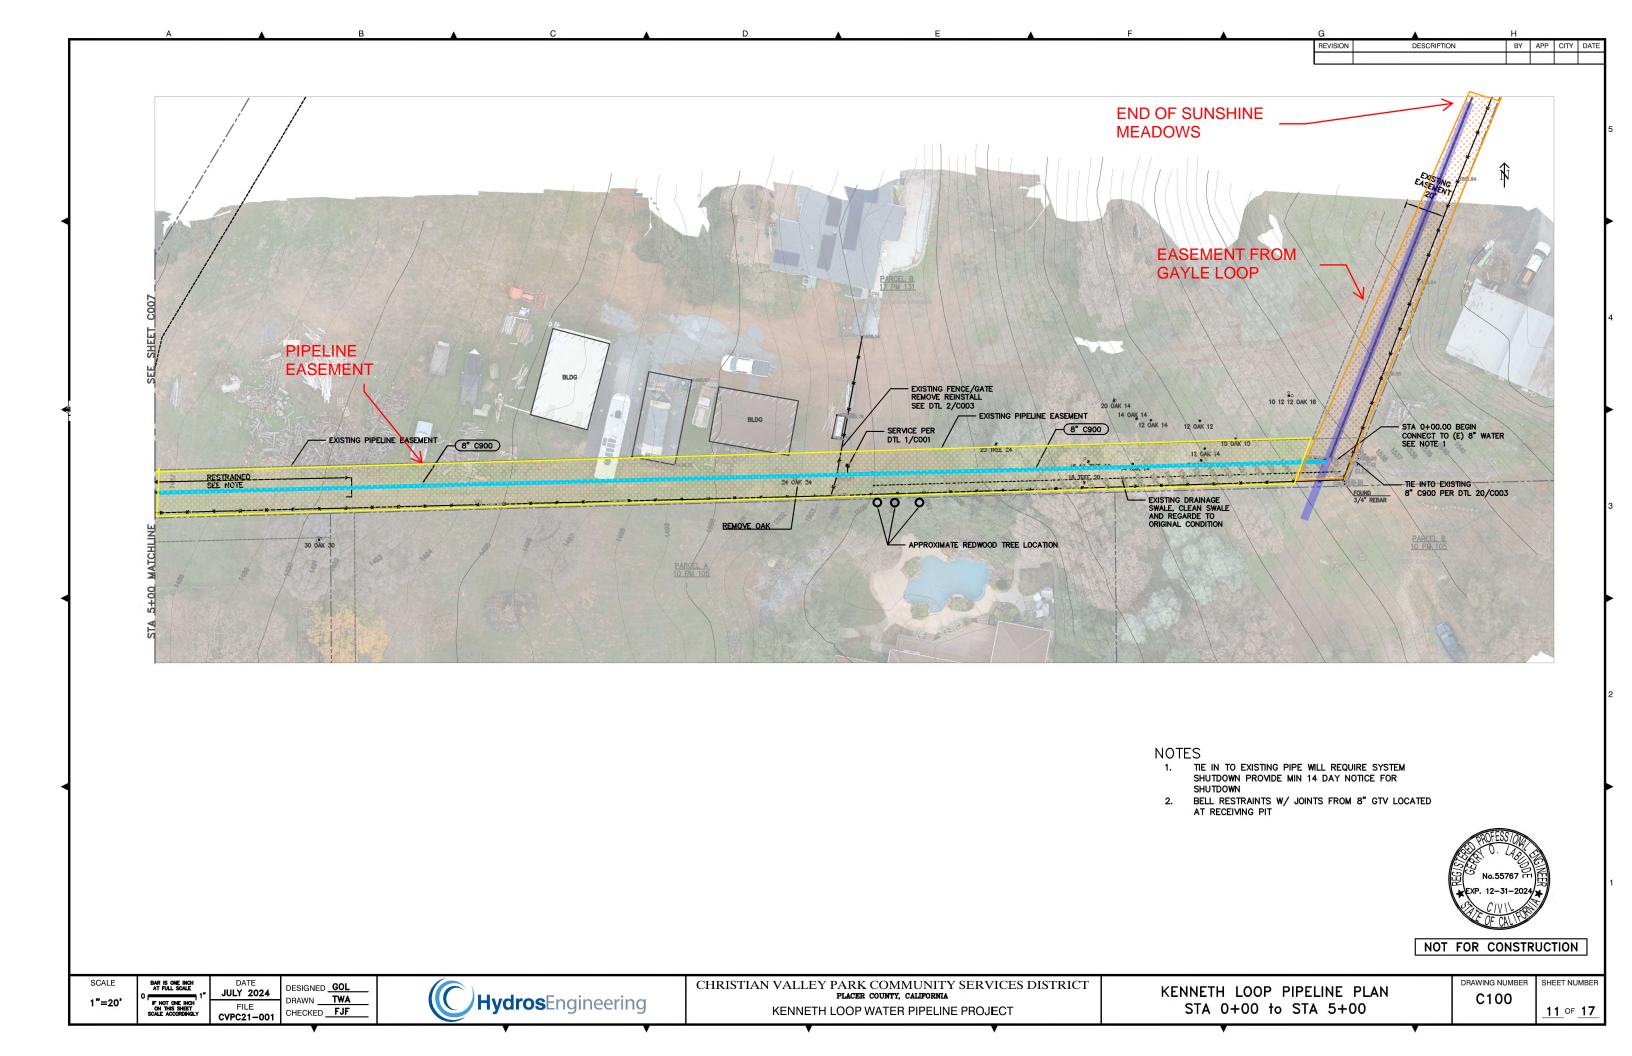

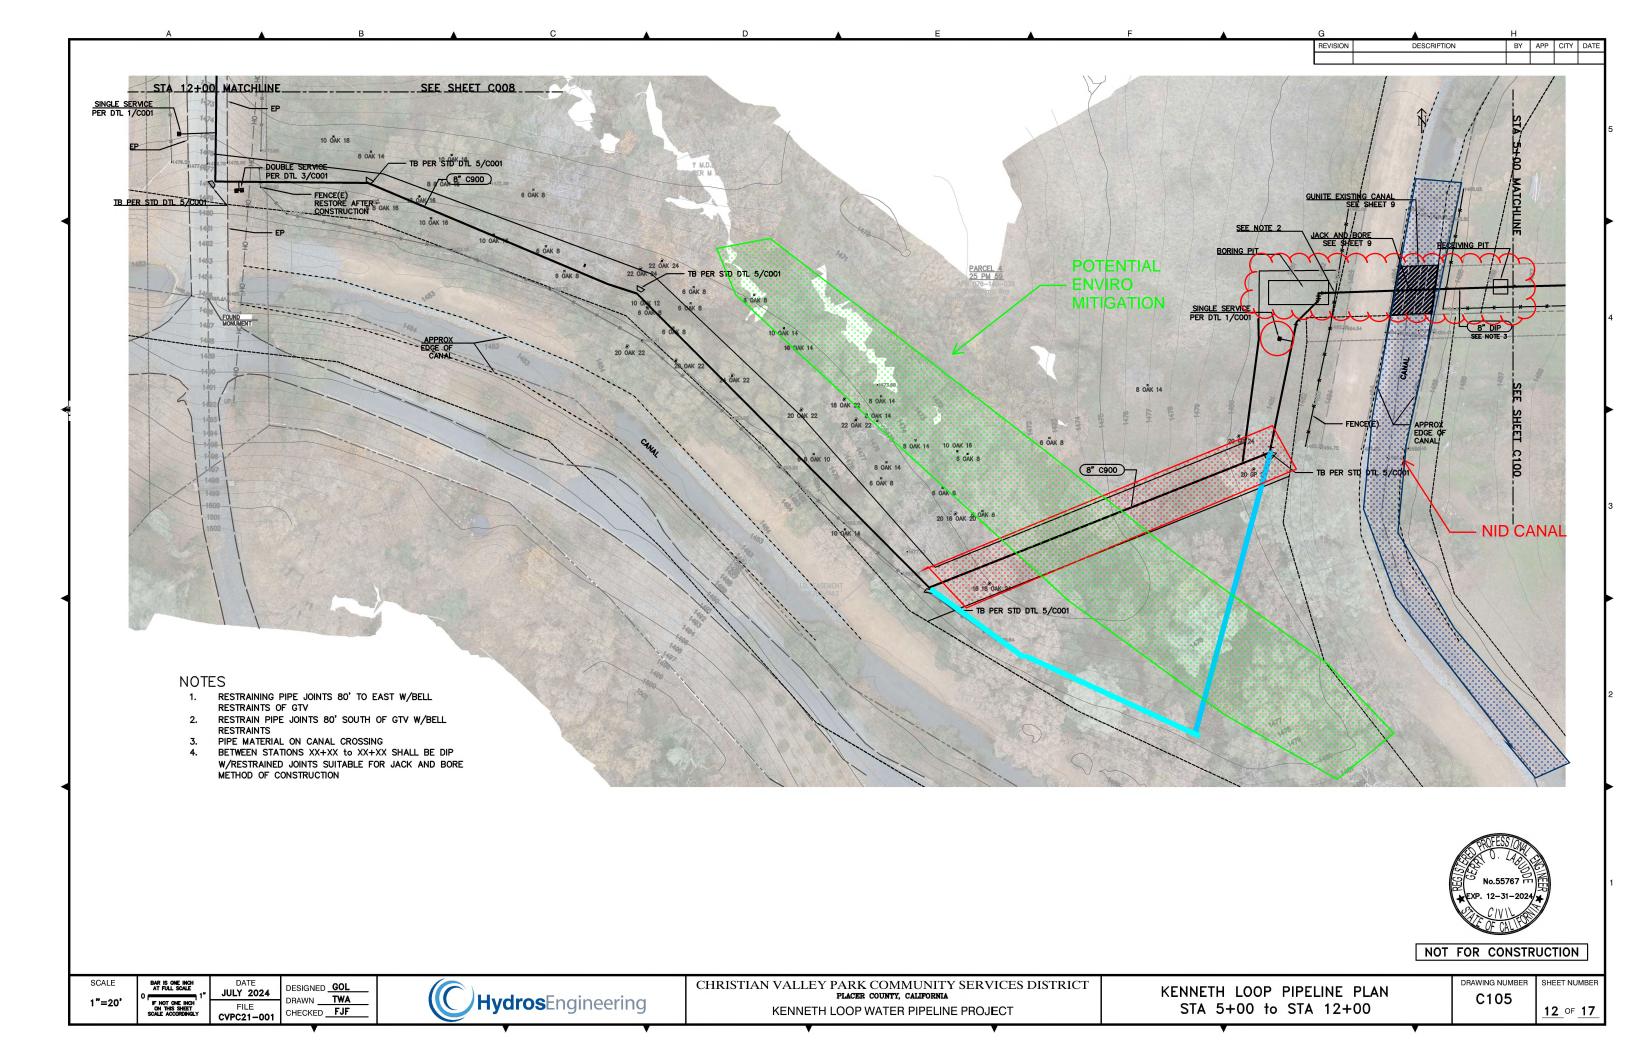

REVISION DESCRIPTION BY APP CITY DATE

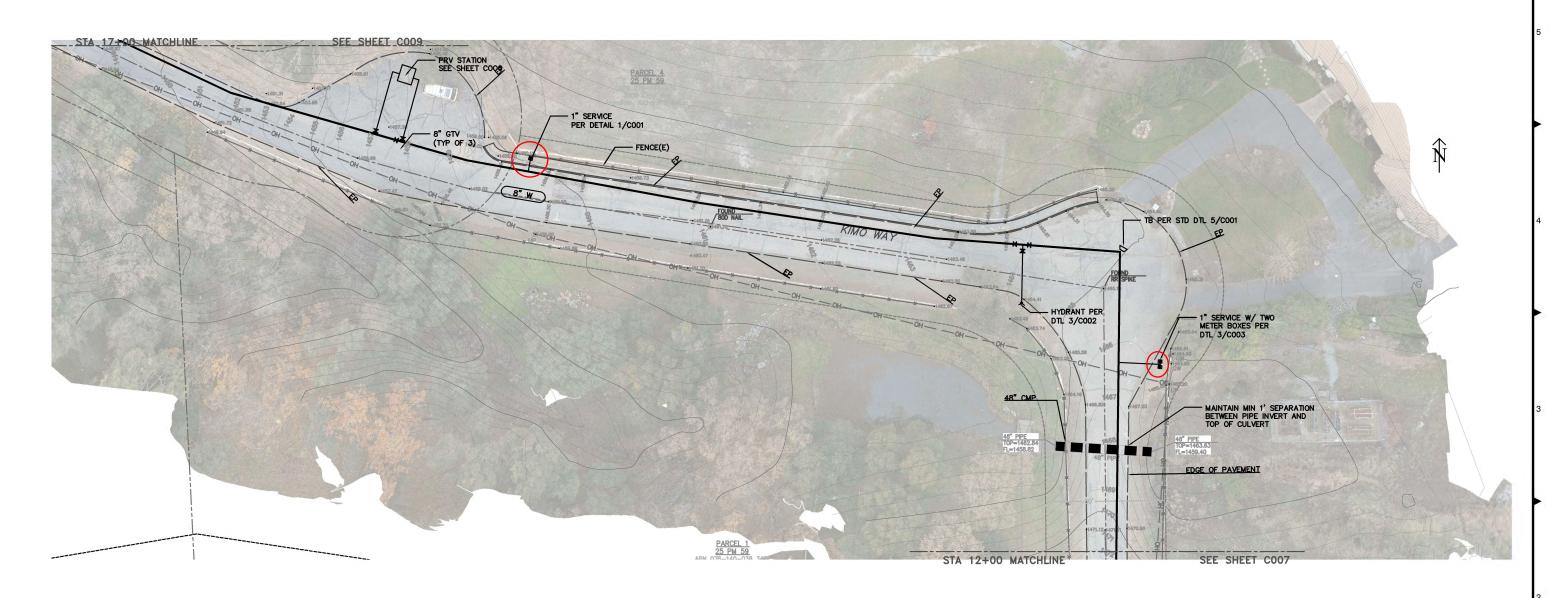

### NOTES

 HYDRANT MAP SERVICE LOCATIONS SHOWN ARE APPROXIMATE FIELD LOCATE W/ ENGINEER DURING CONSTRUCTION



NOT FOR CONSTRUCTION

SCALE

BAR IS ONE AT FULL SC

1"=20"

F NOT ONE ON THIS SH

DATE
JULY 2024

SHEET CORDINGLY

DATE
JULY 2024

FILE
CVPC21-001


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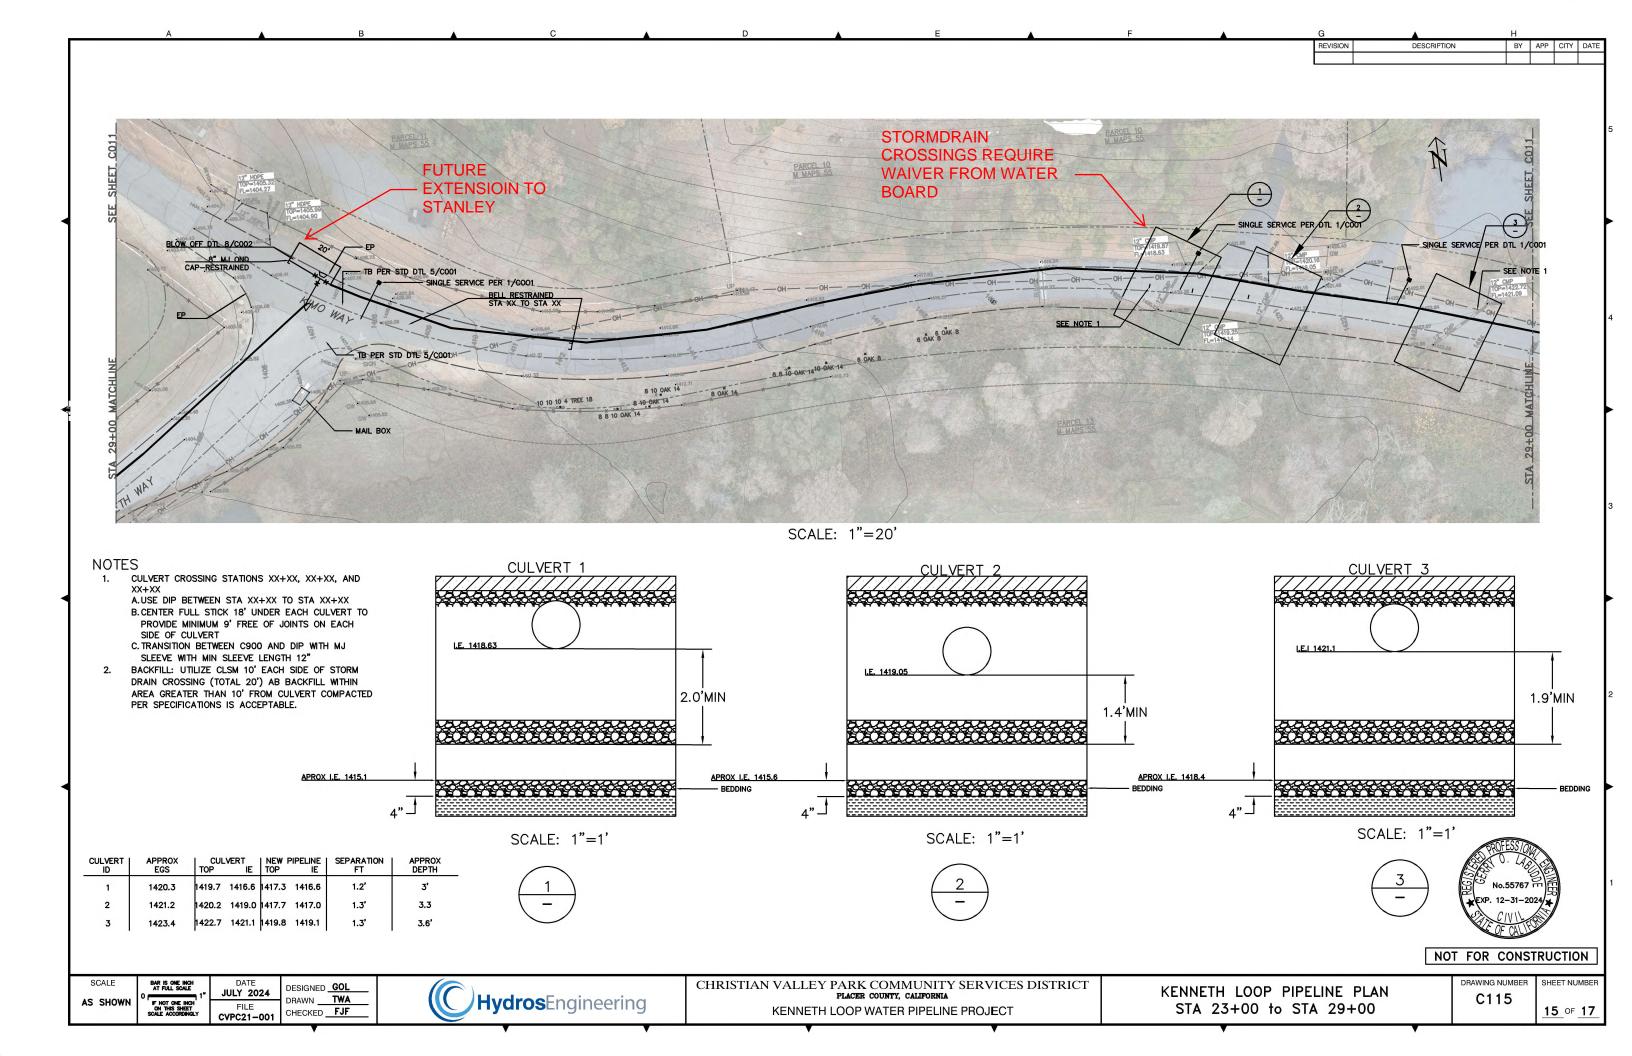



CHRISTIAN VALLEY PARK COMMUNITY SERVICES DISTRICT PLACER COUNTY, CALIFORNIA
KENNETH LOOP WATER PIPELINE PROJECT


KENNETH LOOP PIPELINE PLAN STA 12+00 to STA 17+00 DRAWING NUMBER SHEET NUMBER C010

13 OF 17



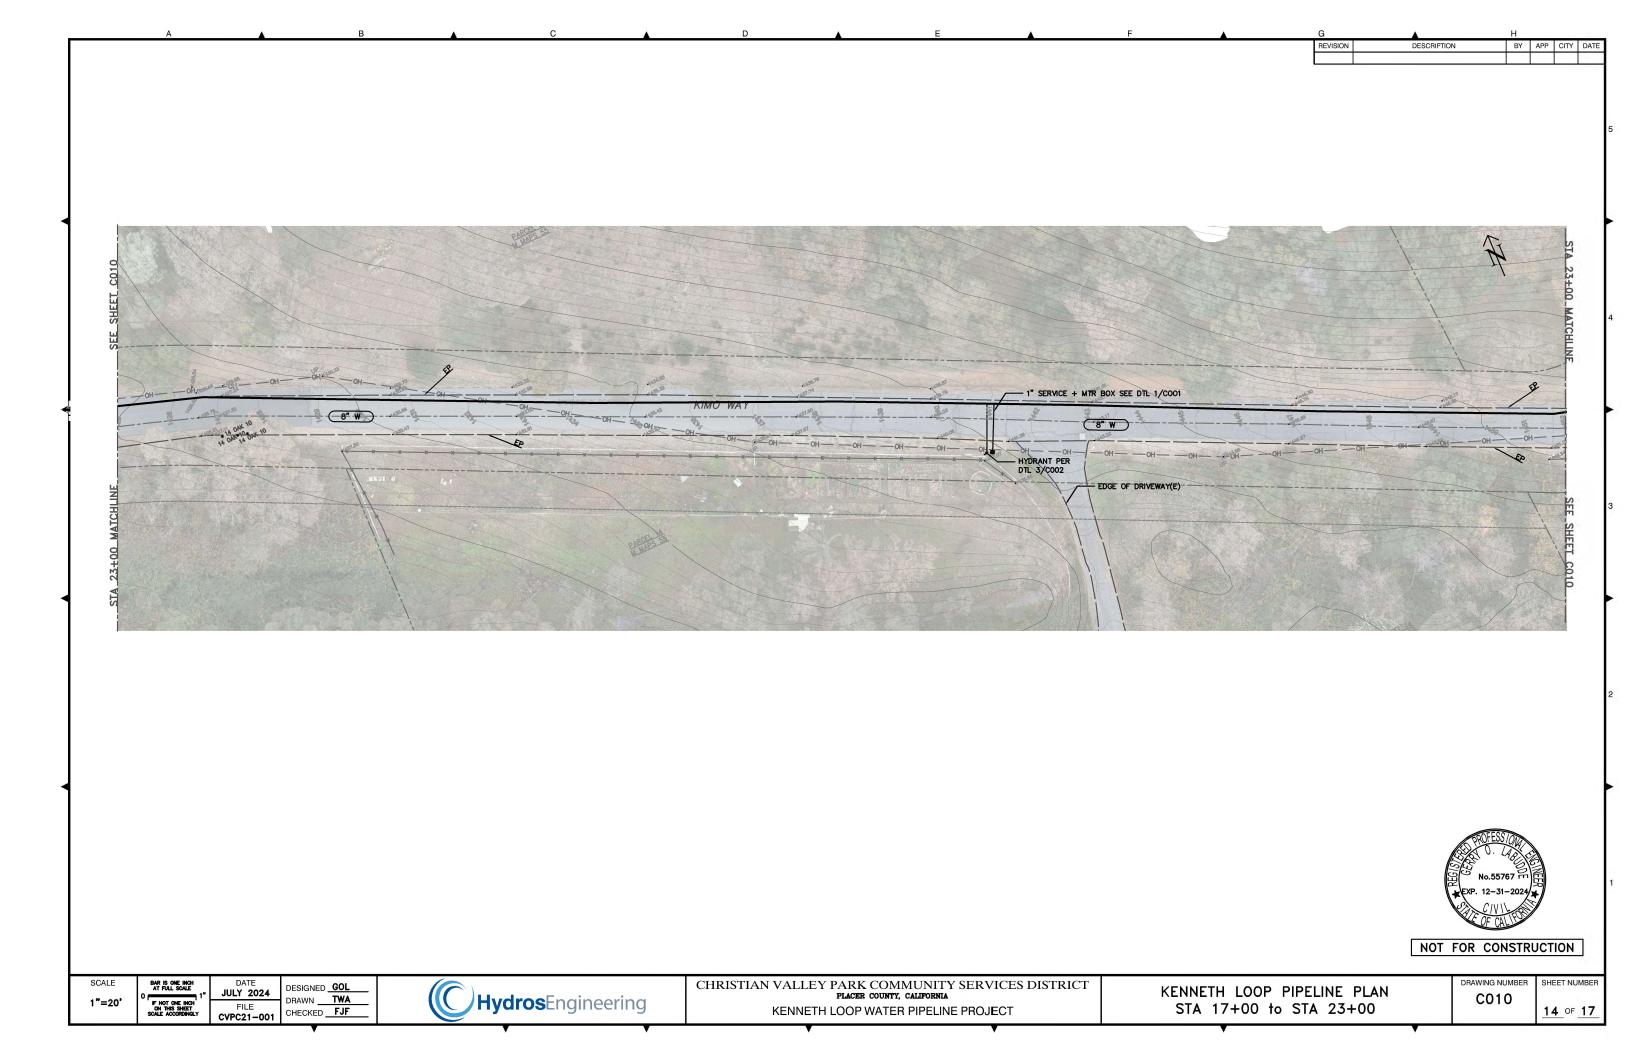

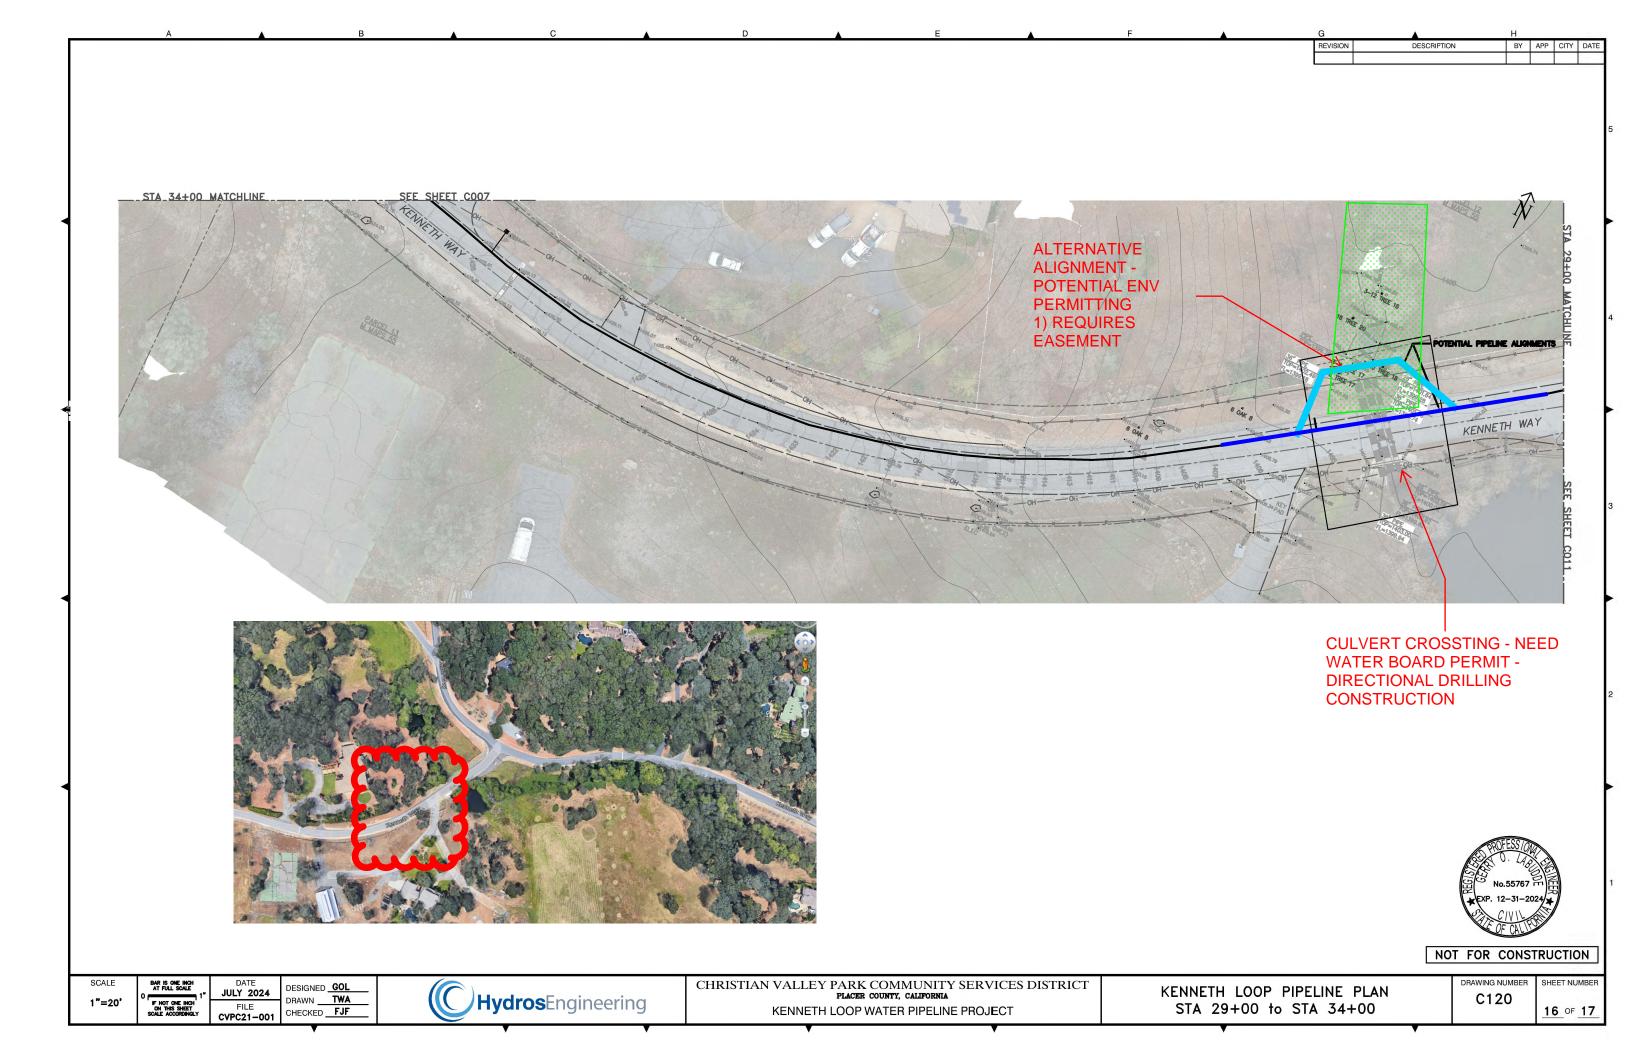

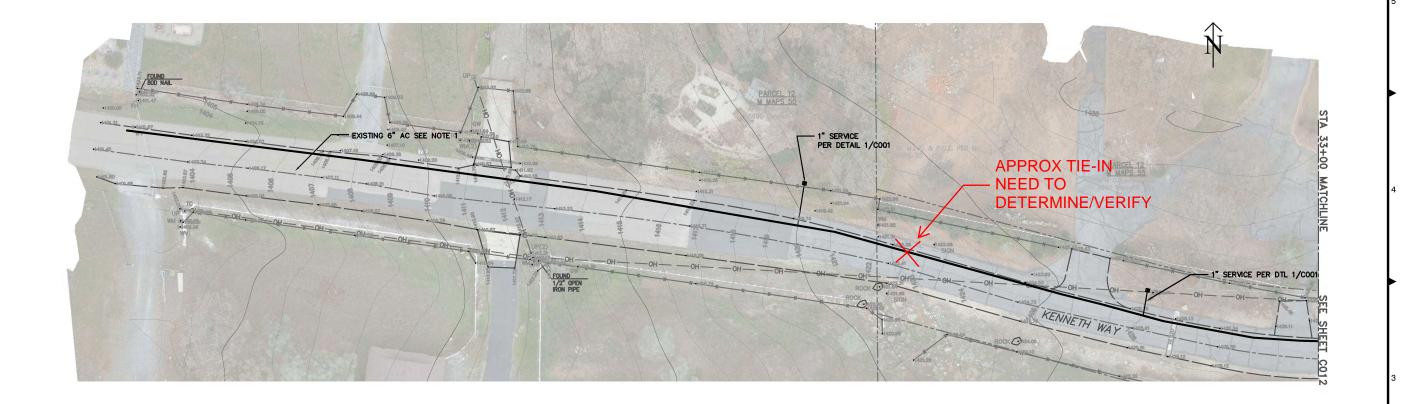

### NOTES:

- CONTRACTOR TO POTHOLE AND VERIFY LOCATION OF EXISTING 6" AC
   SEE DETAIL 18/C003



NOT FOR CONSTRUCTION

1"=20'

DATE JULY 2024 DESIGNED GOL
DRAWN TWA
CHECKED FJF FILE CVPC21-001



CHRISTIAN VALLEY PARK COMMUNITY SERVICES DISTRICT PLACER COUNTY, CALIFORNIA KENNETH LOOP WATER PIPELINE PROJECT

KENNETH LOOP PIPELINE PLAN STA 34+00 to STA 38+00

DRAWING NUMBER SHEET NUMBER C125

17 OF 17